





GENERAL NOTES:

THE PROPOSED OCCUPANCY WILL NOT STORE OR USE HAZARDOUS MATERIALS IN EXCESS OF THOSE ALLOWED IN CBC 307 UNLESS STORED OR UTILIZED IN CONTROL AREAS OR RECLASSIFIED AS A HIGH-HAZARDOUS OCCUPANCY (GROUP HI PER CBC

BUILDING DESIGN NATURAL GAS FREE AS REQUIRED BY SCMC 6.100

RECOMMENDATIONS. AF ADDE FRIENDE ADDRESS SHALL ALLWORK PREFORMED UNDER THIS CONFECT SHALL BE IN ACCORDANCE BY THE CITY OF BOLLET CONCRISTS OF BUILDING CONSISTS OF SAD SF WITH A MECH. ALL WORK PREFORMED UNDER THIS CONFECT SHALL BE IN ACCORDANCE BY THE CITY OF BUILDING CONSISTS OF SAD SF WITH A MECH. ALL WORK PREFORMED UNDER THIS CONFECT SHALL BE IN ACCORDANCE BY THE CITY OF BUILDING CONSISTS OF SAD SF WITH A MECH. ALL WORK PREFORMED UNDER THIS CONFECT SHALL BE IN ACCORDANCE BY THE CITY OF BUILDING CONSISTS OF SAD SF WITH A MECH. ALL WORK PREFORMED UNDER THIS CONFECT SHALL BE IN ACCORDANCE BY THE CITY OF BUILDING CONSISTS OF SAD SF WITH A MECH. ALL WORK PREFORMED UNDER THIS CONFECT SHALL BE IN ACCORDANCE BY THE CITY OF BUILDING CONSISTS OF SAD SF WITH A MECH. ALL WORK PREFORMED UNDER THIS CONFECT SHALL BE IN ACCORDANCE BY THE CITY OF BUILDING CONSISTS OF SAD SF WITH A MECH. ALL WORK PREFORMED UNDER THIS CONFECT SHALL BE IN ACCORDANCE BY THE CITY OF BUILDING CONSISTS OF SAD SE WITH A MECH. ALL WORK PREFORMED UNDER THIS CONFECT SHALL BE IN ACCORDANCE BY THE CITY OF BUILDING CONSISTS OF SAD SE WITH A MECH. ALL WORK PREFORMED UNDER THIS CONFECT SHALL BE IN ACCORDANCE BY THE CITY OF BUILDING CONSISTS OF SAD SE WITH A MECH. ALL WORK PREFORMED UNDER THIS CONFECT SHALL BE IN ACCORDANCE BY THE CITY OF BUILDING CONSISTS OF SAD SE WITH A MECH. BY THE CITY OF BUILDING CONSISTS OF SAD SE WITH A MECH. BY THE CITY OF BUILDING CONSISTS OF SAD SE WITH A MECH. BY THE CITY OF BUILDING CONSISTS OF SAD SE WITH A MECH. BY THE CITY OF BUILDING CONSISTS OF SAD SE WITH A MECH. BY THE CITY OF BUILDING CONSISTS OF SAD SE WITH A MECH. BY THE CITY OF BUILDING CONSISTS OF SAD SE WITH A MECH. BY THE CITY OF BUILDING CONSISTS OF SAD SE WITH A MECH. BY THE CITY OF BUILDING CONSISTS OF SAD SE WITH A MECH. BY THE CITY OF BUILDING CONSISTS OF SAD SE WITH A MECH. BY THE CITY OF BUILDING CONSISTS OF SAD SE WITH A MECH. BY THE CITY OF BUILDING CONSISTS OF SAD SE WITH A MECH. BY THE CITY OF BUILDING CONSISTS OF SAD SE WITH A MECH	PROJECT SUMMARY	INDEX OF DRAWINGS	VICINITY MAP
6 VERIFY ALL EXISTING SITE CONDITIONS, SITE DIMENSIONS, AND BEAM OC ON CENTER PARKING REQUIRED: 1/250 SF = 22 DEAWNING.	REDIGIT CONSISTS OF: ALL WORK PROGRAMED UNDER THIS CONTRACT SHALL BE IN ACC	DANCE GO.1 COVER SHET AND PROJECT INFORMATION (CONCEPTIAL RENDERINGS GO.5 CONCEPTIAL RENDERINGS GO.7 CONCEPTIAL RENDERINGS GO.7 CONCEPTIAL RENDERINGS GO.1 CALGERIC CONCEPTIAL RENDERINGS GO.1 CALGERIC CONCEPTIAL RENDERINGS GO.1 CALGERIC CONTRIBUTE CHICAST GO.15 GREEN BUILDING CHICAST GO.17 DEVINING PLANS	PROJECT S Out Cus D Tomas g Fam 8:

A-3 YES, FULLY SPRINKLERED

60 FEET/2 STORIES

BUILDING INFORMATION

AREA PER STORY: 1ST FLOOR: 5,434 SF

TOTAL = 5,434 SF

FIRE RESISTIVE REQUIREMENTS

NUMBER OF STORIES 1

TYPE OF CONSTRUCTION: V-B

FIRE SPRINKLERED:

OCCUPANCY:

AREA OF WORK-ALLOWABLE HEIGHT:

DRIP LINE BUILDING. AREA: INTERIOR FINISH BUILDING. AREA: LOT COVERAGE: LOOR AREA RATIO ON CENTER OVERFLOW DRAIN POURED IN PLACE ACCESSIBLE: LANDSCAPE COVERAGE FLOOD ZONE DESIGNATION: FLASHING SUPPLIED BY OWNER

ROOF DRAIN

REFERENCE

SCHEDULE SHEET

SIMILAR

STANDARD

SERVICE SINK SANITARY SEWER

SHELF SUSPENDED

TO BE DETERMINED

UNLESS OTHERWISE NOTED

VINYL COMPOSITION TILE

HINLESS NOTED

WATER CLOSET

WIRE GLASS

TOP & BOTTOM

TELEPHONE TEMPORARY

TYPICAL

WIDE

SLAB ON GRADE SPECIFICATION SQUARE

REQUIRED SELF ADHERED

ROOM

SCH

SHWR SIM SOG SHOWER

STL STEEL STORAGE STAINLESS STEEL

T&B

UON

UNO

VCT

CLEAR CENTER LINE

CERAMIC TILE CLEAN OUT

CONTINUOUS

DIAMETER

DISPENSER

ELEVATION EQUAL EXTERIOR

FINISH FLOOR

FINISH FACE FLOOR DRAIN FIRE EXTINGUISHER

FACE OF CONCRETE FACE OF STUD FACE OF PLY FIRE RESISTIVE

FIGURE IT OUT

FACE OF STUD

GALVANIZED SHEET

GYPSUM BOARD

HOLLOW METAL

GLASS

HOUR HANDICAPPED HARDWOOD

HARDWARE INSTITATION

GYP BD HT HM

EXISTING

ALLOWABLE AREA CALCULATIONS

PER TABLE 506.2: FOR OCCUPANCY CLASSIFICATION A-3, SPRINKLERED, ONE STORY, TYPE V-B = 24,000 SQ FEET MAXIMUM

INSULATION	REQUIREMENTS:

SYMBOLS

 \otimes

FLOORS:	R-0
WALLS: > EXTERIOR > INTERIOR	R-XX R-19
ROOF:	R-30
STOREFRONT GLASS & DOORS	NFRC 200

SECTION CUT NUMBER

SPECIFIC ELEVATION

SPECIFIC ELEVATION

OFFICE ROOM NAME

101 ROOM NUMBER

DRAWING SHEET NUMBER

DRAWING SHEET NUMBER

DRAWING SHEET NUMBER

STRUCTURAL FRAME:	0 HOUR
EXTERIOR BEARING WALLS:	0 HOUR
INTERIOR BEARING WALLS:	0 HOUR
EXTERIOR NON-BEARING WALLS & PARTITIONS:	0 HOUR
FLOOR CONSTRUCTION:	0 HOUR
ROOF CONSTRUCTION:	0 HOUR

PLUMBING FIXTURE COUNT

MINNIMUM FIXTURES PER TABLE 422.1 FOR A-3 OCCUPANCY:

MEN:		WOMEN:	
TOILET:	1	TOILET:	3
URINAL:	1	SINK:	1
SINK: 1			
DRINKING	FOUNTAIN:	1	
IANITOR'S	SINK-	1	

TOILET: URINAL: SINK:	2 1 2	TOILET: SINK:	2	
	FOUNTAIN:	1		
JANITOR'S		1		

FIXTURES PROVIDED:

ARCHITECTURAL:

ELECTRICAL:

A1.1	MASTER SITE & PARKING PLAN
A1.2	SITE PLAN
A2.1	GROUND LEVEL PLAN
A2.2	EQUIPMENT PLATFORM PLAN
A2.3	ROOF LEVEL PLAN
A3.1	BUILDING ELEVATIONS
A3.2	BUILDING ELEVATIONS
A3.5	BUILDING SECTIONS

A3.6 BUILDING SECTIONS A5.0 EXTERIOR LIGHTING STANDARDS

CIVIL (FOR REFERENCE ONLY): PLUMBING:

STRUCTURAL:



NERAL NOTES: INTRACTOR SHALL FIELD VERIFY ALL JOB CONDITIONS AND DIMENSIONS. VARIATIONS HEREOF FROM THE DRAWINGS MUST BE REPORTED TO THE ARCHITECT. DETAILS DIDICATED ON THE DRAWINGS ARE REPRESENTATIVE AND TYPICAL. ALL ATTACHMI NO CONNECTIONS SHALL CONFORM TO BEST PRACTICE AND SHALL BE THE DISTRACTOR'S RESPONSIBILITY.

ΚĖ	EVISIONS				
NO.	DATE	DESCRIPTION	BY		

COVER SHEET AND PROJECT INFORMATION

JOB NO.	
DATE: 09/15/20	
DRAWN:	
CHECKED:	
ISSUE: PLANNING SUBMITTAL	

SHEET NO. G0.1

APPROVENIATE GAMS BOX TO MEET TITLE 24.

ALL RECEPTACLES & PHONE/DATA JACKS SHALL BE STANDARD PLATE:
IN MANUFACTURER'S STANDARD TRIM COLOR, TO BE APPROVED BY
ARCHITECT, MOUNTED VERTICALLY LEVEL WITH ELECTRICAL

DESCRIPTACLES LINE. ARCHITECT, MOUNTED VERTICALLY LEVEL WITH ELECTRICAL RECEPTACLES. U.N.O. EXIT SIGNAGE TO BE GREEN LED. IN WHITE THERMOPLASTIC HOUSING. T.I. TO MATCH SHELL STANDARD.

GRADES PRIOR TO START OF WORK. IF ANY DISCREPANCIES OCCUR BETWEEN THE DRAWINGS AND ACTUAL FIELD CONDITIONS, NOTIFY THE ARCHITECT AT ONCE. SITE ACCESSIBILITY IS SUBSTANTIALLY IN COMPLIANCE WITH CALIF.

TITLE 24 REQUIREMENTS, TO BE VERIFIED IN FIELD. IF NEEDED APPLICABLE PLANS, DETAILS & SPECIFICATIONS MUST BE APPROVED PRIOR TO FINAL INSPECTION

CONNECTIONS TO EXISTING PUBLIC UTILITIES SHALL BE DONE WITH

REQUIREMENTS.

CONTRACTORS SHALL PROTECT ALL EXISTING SITE IMPROVEMENTS

NOT SCHEDULED FOR REMOVAL DURING CONSTRUCTION. THEY

SHALL REPAIR ANY DAMAGE TO NEW CONSTRUCTION AT THEIR

EXPENSE.

DO NOT CONNECT OR SUSPEND ANY ITEM FROM STRUCTURE WITHOUT PRIOR APPROVAL FROM THE STRUCTURAL ENGINEER PARTITION CONNECTION & ANCHORING TO FIRE SAFING IS NOT

PARTITION CONNECTION & ANYIODING TO FIRE SAFING IS NOT ALLOWED.

WORK MAN BE DESERVED BY THE ARCHITECT AND THE OWNER'S REPRESENTATIVES FOR COMPONENT WITH THE CONSTRUCTION CONCLAID BEFORE BINNG DOSERVED SHALL BY OPPHED AND CONCLAID DISCORD ROUGHST THE CONTRACTOR SESSONSIBLE FOR NOTFING THE ARCHITECT AND THE OWNER OF ALL REQUIRED DISCREVATIONS IN ADVANCE. ON ALLOWINGES SHALL IN

OBSERVATIONS IN ADVANCE. NO ALLOWANCE SHALL
SUBSCUENTLY BE MADE IN THE CONTRACTOR'S BEHALF FOR ANY
NEGLECT IN ADHERING TO THIS REQUIREMENT.
13 FOR METAL STUD INTEROR PARTITION WALL SZE, GAUGE AND
SPACING, SEE WALL DETAILS AND SCHEDULE.
14 GYPSUM BOARD FOR NON-FIRE RESISTIVE WALLS TO BE 5/8" THICK

15 GYPSUM BOARD FOR FIRE RESISTIVE WALLS TO BE TYPE 'X' 5/8" THICK U.N.O.

MANUFACTURER'S RECOMENDATIONS FOR CONDITIONS AS

SCHEDULED TO RECEIVE CERAMIC TILES.

ALL DUCT AND CONDUT PENETRATIONS THROUGH PARTITIONS
SHALL BE FIRE SEALED OR ACOUSTICAL SEALED.

19 ALL SHAFT ENCLOSURES CONTAINING AIR NOT IN DUCTS SHALL BE
SEALED AIRTICHT.

20 TAPE, BED AND FINISH ALL DRYWALL CORNERS AND JOINTS READY

21 HEIGHT OF FURNITURE PARTITIONS IN OPEN OFFICE AREA SHALL

22 LIGHT SWITCH/MOTION SENSOR ASSEMBLIES SHALL BE PROVIDED IN APPROPRIATE GANG BOX TO MEET TITLE 24.

USE 5/8" THICK MOISTURE RESISTANT GYPSUM BOARD AT ALL WALLS IN TOILET ROOMS AND SHOWER AREAS AND AT ALL WALLS SCHEDULED TO RECEIVE CERAMIC TILES.

16 ALL FIRE RESISTIVE PARTITIONS SHALL BE CONSTRUCTED IN

COMPLIANCE WITH UL TESTING REQUIREMENTS AND

CONFORM TO THE RECOMMENDATIONS OF THE SOILS REPORT

APPROVAL AND IN ACCORDANCE WITH THE UTILITY CO. REQUIREMENTS.

PREPARED BY:

REQUIRED

FOR FINISH.

NOT EXCEED 5'-9".



VIEW 1: MAIN ENTRY VIEW



VIEW 2: ALLEY BETWEEN THEATER AND DANCE STUDIO



GENERAL NOTES:
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AND CONNECTIONS SHALL CONFORM TO BEST PRACTICE AND SHALL BE THE

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CONCEPTUAL RENDERINGS

JOB NO.	SHEET NO.	
DATE: 09/15/2020		
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ISSUE: PLANNING SUBMITTAL	OF SHE	ET:



VIEW 3: VIEW OF LOBBY



VIEW 4: VIEW OF LOBBY

C
TANNERY ARTS CENTER
DANCE STUDIO
1020 RIVER STREET SANTA CRUZ, CA


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CONCEPTUAL RENDERINGS

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DATE: 09/15/20]	_
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VIEW 5: INTERIOR OF DANCE STUDIO #1



VIEW 6: VIEW FROM PARKING AREA

TANNERY ARTS CENTER
DANCE STUDIO
1020 RIVER STREET SANTA CRUZ, CA

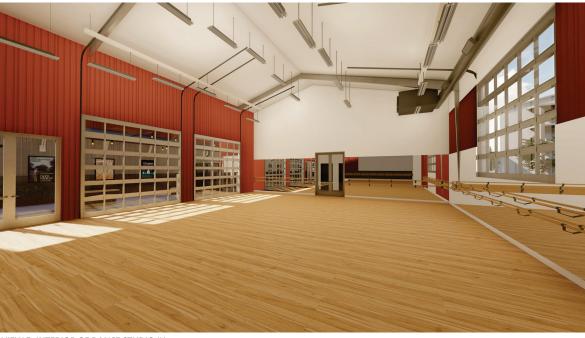GENERAL NOTES:
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AND CONNECTIONS SHALL CONFORM TO BEST PRACTICE AND SHALL BE THE

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CONCEPTUAL RENDERINGS

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OF

A5.602 CALGreen VERIFICATION GUIDELINES MANDATORY MEASURES CHECKLIST (2019 SUPPLEMENT effective July 1, 2021)

Application: This checklist shall be used for nonresidential projects that meet one of the following: new construction, building additions of 1,000 square feet or greater, or building attentions with a permit valuation of \$200,000 or more pursuant to Section 301.3 AND do not trigger a Tier 1 or Tier 2 requirement:

Chapter 5 Divisions

Requirement	SECTION TITLE	SECTION	Y	N	N/A	0	PLAN SHEET, SPEC OR ATTACH REFERENCE
Mandatory	Storm water pollution prevention for projects that disturb less than 1 acre of land	5.106.1 through 5.106.2					
Mandatory	Short-term bicycle parking (with exception)	5.106.4.1.1					
Mandatory	Long-term bicycle parking	5.106.4.1.2 through 5.106.4.1.5	Г				
Mandatory	Designated parking for clean air vehicles with footnote and note	5.106.5.2					
Mandatory	Parking stall marking	5.106.5.2.1					
Mandatory	Single charging space requirements	5.106.5.3.1					
Mandatory	Multiple charging space requirements [N]	5.106.5.3.2					
Mandatory	EV charging space calculation [N] (with exceptions)	5.106.5.3.3	Г				
Mandatory	[N] Identification	5.106.5.3.4					
Mandatory	[N] Future charging spaces with note	5.106.5.3.5	Г				

Requirement	SECTION TITLE	SECTION	Y	N	N/A	0	PLAN SHEET, SPEC, OR ATTACH REFERENCE
Mandatory	Light pollution reduction [N] (with exceptions, notes and table)	5.106.8					
Mandatory	Grading and paving (exception for additions and alterations not altering the drainage path)	5.106.10					

	DIVIS	ION 5.2 Energ	yΕ	ffici	ency		
tequirement	SECTION TITLE	SECTION	Υ	N	N/A	0	PLAN SHEET, SPEC, OR ATTACH REFERENCE
fandatory	Meet the minimum energy efficiency	5.201.1					

	DIVISION 5.3 W	ater Efficien	су а	nd	Conse	rvat	tion
Requirement	SECTION TITLE	SECTION	Υ	N	N/A	0	PLAN SHEET, SPEC, OR ATTACH REFERENCE
Mandatory	Separate meters (new buildings or additions > 50,000 sfthat consume more than 100 gal/day)	5.303.1.1					
Mandatory	Separate meters (for tenants in new buildings or additions that consume more than 1,000 gal/day)	5.303.1.2					
Mandatory	Water closets shall not exceed 1.28 gallons per flush (gpf)	5.303.3.1	Г				
Mandatory	Wall-mounted urinals shall not exceed 0.125 gpf	5.303.3.2.1					
Mandatory	Floor-mounted urinals shall not exceed 0.5 gpf	5.303.3.2.2					

Requirement	SECTION TITLE	SECTION	Υ	N	N/A	0	PLAN SHEET, SPEC, OR ATTACH REFERENCE
Mandatory	Single showerhead shall have maximum flow rate of 1.8 gpm (gallons per minute) at 80 psi	5.303.3.3.1					
Mandatory	Multiple showerheads serving one shower shall have a combined flow rate of 1.8 gpm at 80 psi	5.303.3.3.2					
Mandatory	Nonresidential lavatory faucets	5.303.3.4.1		Г			
Mandatory	Kitchen faucets	5.303.3.4.2					
Mandatory	Wash fountains	5.303.3.4.3					
Mandatory	Metering faucets	5.303.3.4.4					
Mandatory	Metering faucets for wash fountains	5.303.3.4.5		Г			
Mandatory	Pre-rinse spray valve	5.303.3.4.6					
Mandatory	Food waste disposers	5.303.4.1					
Mandatory	Areas of additions or alterations	5.303.5		Г			
Mandatory	Standards for plumbing fixtures and fittings	5.303.6					
Mandatory	Outdoor potable water use in landscape areas (with notes)	5.304.1					

Requirement	SECTION TITLE	SECTION	Y	N	N/A	0	PLAN SHEET, SPEC, OR ATTACH REFERENCE
Mandatory	Weather protection	5.407.1				П	
Mandatory	Moisture control: sprinklers	5.407.2.1					
Mandatory	Moisture control: exterior door protection	5.407.2.2.1	Г	Г		П	
Mandatory	Moisture control: flashing	5.407.2.2.2	Г				

Requirement	SECTION TITLE	SECTION	Y	N	N/A	0	PLAN SHEET, SPEC, OR ATTACH REFERENCE
Mandatory	Construction waste management—comply with either: Sections 5.408.1.1, 5.408.1.2, 5.408.1.3 or more stringent local ordinance	5.408.1.1, 5.408.1.2, 5.408.1.3					
Mandatory	Construction waste management: documentation	5.408.1.4					
Mandatory	Universal waste [A]	5.408.2	П	П		П	
Mandatory	Excavated soil and land clearing debris (100% reuse orrecycle)	5.408.3					
Mandatory	Recycling by occupants (with exception)	5.410.1	Г				
Mandatory	Recycling by occupants: additions (with exception)	5.410.1.1					
Mandatory	Recycling by occupants: sample ordinance	5.410.1.2					
Mandatory	Commissioning new buildings (≥ 10,000 sf) [N]	5.410.2					
Mandatory	Owner's or owner representative's Project Requirements (OPR) [N]	5.410.2.1					
Mandatory	Basis of Design (BOD) [N]	5.410.2.2					
Mandatory	Commissioning plan [N]	5.410.2.3					
Mandatory	Functional performance testing [N]	5.410.2.4					
Mandatory	Documentation and training [N]	5.410.2.5					
Mandatory	Systems manual [N]	5.410.2.5.1					
Mandatory	Systems operation training [N]	5.410.2.5.2					

						TANNERY	ARTS CENTER
CODE SECTION	Y	N	N/A	0	PLAN SHEET, SPEC, OR ATTACH REFERENCE		CE STUDIO
5.408.1.1, 5.408.1.2, 5.408.1.3							
5.408.1.4							
5.408.2						1	
5.408.3							
5.410.1							
5.410.1.1							
5.410.1.2							
5.410.2							
5.410.2.1							
5.410.2.2	Г			Г			
5.410.2.3							
5.410.2.4							
5.410.2.5	L	L		L			
5.410.2.5.1 E.410.2.E.2			-			- 1	

Requirement	SECTION TITLE	SECTION	Y	N	N/A	0	PLAN SHEET, SPEC, OR ATTACH REFERENCE		SECTION TITLE	CODE SECTION	Y	N	N/A	0	PLAN SHEET, SPE OR ATTACH REFERENCE
Mandatory	Commissioning report [N]	5.410.2.6	Г					Mandatory	Aerosol paints and coatings: verification	5.504.4.3.2					
Mandatory	Testing and adjusting	5.410.4						Mandatory	Carpet systems	5.504.4.4	П				
	for new buildings <							Mandatory	Carpet cushion	5.504.4.4.1					
	10,000 sf or new systems that serve additions or alterations							Mandatory	Carpet adhesives per Table 5.504.4.1	5.504.4.4.2					
	[A]					Ш		Mandatory	Composite wood products	5.504.4.5					
Mandatory	System testing plan for renewable energy, landscape irrigation and water reuse [A]	5.410.4.2						Mandatory	Composite wood products: documentation	5.504.4.5.3					
Mandatory	Procedures for testing and adjusting	5.410.4.3	Г					Mandatory	Resilient flooring systems	5.504.4.6					
Mandatory	Procedures for HVAC balancing	5.410.4.3.1	Г					Mandatory	Resilient flooring: verification of	5.504.4.6.1					
Mandatory	Reporting for testing and adjusting	5.410.4.4						Mandatory	compliance Filters (with exceptions)	5.504.5.3	Н	H		H	
Mandatory		5.410.4.5	\vdash	\vdash	-	\vdash		Mandatory	Filters (with exceptions)	5.504.5.3.1	Н	\vdash		\vdash	
wandatory	Operation and maintenance (O&M) manual	0.410.4.0						Mandatory	Environmental tobacco smoke (ETS) control	5.504.7	Н				
Mandatory	Inspection and reports	5.410.4.5.1						Mandatory	Indoor moisture control	5.505.1	Н				

Requirement	SECTION TITLE	SECTION	Y	N	N/A	0	PLAN SHEET, SPEC, OR ATTACH REFERENCE
Mandatory	Fireplaces	5.503.1	П			Г	
Mandatory	Woodstoves	5.503.1.1	Т			П	
Mandatory	Temporary ventilation	5.504.1	Т			П	
Mandatory	Covering of ducts openings and protection of mechanical equipment during construction	5.504.3					
Mandatory	Adhesives, sealants, and caulks	5.504.4.1	Г				
Mandatory	Paints and coatings	5.504.4.3	Т				
Mandatory	Aerosol paints and coatings	5.504.4.3.1				Г	

		SECTION	ľ	"	 ľ	OR ATTACH REFERENCE
Mandatory	Aerosol paints and coatings: verification	5.504.4.3.2				
Mandatory	Carpet systems	5.504.4.4				
Mandatory	Carpet cushion	5.504.4.4.1				
Mandatory	Carpet adhesives per Table 5.504.4.1	5.504.4.4.2		Г		
Mandatory	Composite wood products	5.504.4.5	Г		Г	
Mandatory	Composite wood products: documentation	5.504.4.5.3				
Mandatory	Resilient flooring systems	5.504.4.6				
Mandatory	Resilient flooring: verification of compliance	5.504.4.6.1				
Mandatory	Filters (with exceptions)	5.504.5.3	П	П		
Mandatory	Filters: labeling	5.504.5.3.1				
Mandatory	Environmental tobacco smoke (ETS) control	5.504.7	Г			
Mandatory	Indoor moisture control	5.505.1	П			
Mandatory	Outside air delivery	5.506.1				
Mandatory	Carbon dioxide (CO2) monitoring	5.506.2	Г			
Mandatory	Acoustical control (with exception)	5.507.4	Г			
Mandatory	Exterior noise transmission, prescriptive method (with exceptions)	5.507.4.1				
Mandatory	Noise exposure where noise contours are not readily available	5.507.4.1.1				
Mandatory	Performance method	5.507.4.2	Г	Г		
Mandatory	Site features	5.507.4.2.1				
Mandatory	Documentation of compliance	5.507.4.2.2				
Mandatory	Interior sound transmission (with note)	5.507.4.3				

	SECTION TITLE	SECTION	Y	N	N/A	0	PLAN SHEET, SPEC, OR ATTACH REFERENCE
Mandatory	Ozone depletion and greenhouse gas reductions	5.508.1					
Mandatory	Chlorofluorocarbons (CFCs)	5.508.1.1		Г			
Mandatory	Halons	5.508.1.2	П				
Mandatory	Supermarket refrigerant leak reduction for retail food stores 8,000 square feet or more	5.508.2 through 5.508.2.6.3					
	END OF MANDATORY PROVISIONS		Г				

Documentation Author's / Responsible Design Mandatory: I attest that this mandatory procurate and complete.	
Signature:	
Company:	Date:
Address:	License:

GENERAL NOTES:
CONTRACTOS SHALL FIELD VERIFY ALL DIS CONDITIONS AND DIMENSIONS AVAILATIONS
CONTRACTORS SHALL FIELD VERIFY ALL DIS CONDITIONS AND DIMENSIONS. AVAILATIONS
UNIOCATED ON THE ADMINISTIC SHEEP SHALL FOR THE ADMINISTRATION AND TO THE ADMINISTRATION AND THE ADMINISTR

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10.	DATE	DESCRIPTION	BY
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CALGREEN COMPLIANCE CHECKLIST

JOB NO.	SHEET NO.
DATE: 08/05/21	
DRAWN:	G0.10
CHECKED:	
ISSUE: PLANNING SUBMITTAL	OF SHEETS

TAC DANCE STUDIO | 1020 RIVER STREET City of Santa Cruz Non-Residential Green Building Checklist

NEW CONSTRUCTION PROJECTS

NEW CONSTRUCTION PROJECTS

INSTITUTIONS

INSTITUTION

INST

TAC DANCE STUDIO | 1020 RIVER STREET

Maximum Available Points =	84		- Total Achieved Poi	nts
Measures highlighted yollow are modatory for all new construction. Measures with a start (+) we get of the Design Checkling for Planning Stage, to be considered as early as feasible in the design and planning process. See Guidelines for more information. All code references are CAL Green unless otherwise noted. Exceeding the minimum point requirements by 15-20% is recommended to allow for proced modifications.	Maximum Points	Achieved Points	Plan Pages (e.g., A-1, C-3)	Notes
Ston				
M1a. Construction Activity Pollution Prevention: Prepare SWPP if Ti disturbs 2 1 acre of land	M			
M1b. Stormwater Management: Locate BMPs on site map per CAL Green 5.105.1.2 if Ti disturbs < 1 acre of land	M			
M2. Grading & Paving: Demonstrate Surface Water Control to Prevent Entry at Building Perimeter per 5.105.10	M			
M3, Light Pollution Reduction: Demonstrate Outdoor Lighting System Compliance per CAL Green 5.108.8	M			
M4. Bicycle Parking (5%): Required if ≥ 10 visitor parking spaces OR generates visitor traffic 5.106.4.1.1	M	-		
M5. Bicycle Storage (\$%): Required if ≥ 10 tensor-occupants per CAL Green 5 106 4 1.2	M			
Mt. Clean Air Vehicle Spaces (8%): Required if ≥ 10 vehicular perking spaces per CAL Green Table 5.105.5.2	M	-		
M7. EV Changing Spaces + 260V/40A raceway (6%): Required if a 10 parking space(s) per CAL Green 5:106.5.3	M			
8. Site Selection, Roof & Building Orientation: Maximize solar access	1			
Development Density & Community Connectivity: Preference given to urban sites w/ pedestrian access	1			
10. Brownfield Redevelopment: Ste rehabilitation	1			
11a. Alternative Transportation: Public Transportation Access-perform survey, analyze & reduce auto impacts	1			
11b. Alternative Transportation: Add 1 complete EV Charging Station (voluntary) and satisfy CALGreen 5.106.5.3	1			
12a. Reduce Site Disturbance: Protect or Restore Habitat	1			
12b. Reduce Site Disturbance: Maximize Open Space	1			
12c, Reduce Site Disturbance: Exceed City Ordinance by 25%	1			
 Stormwater Management: Incorporate One LID: Sidewalk Swale; Roottop Garden; Roof Leader Disconnect 	1			
14a. Heat Island Effect: Non-Roof: Replace constructed surfaces with vegetation or other high-aibedo surface	1			
14b. Heat Island Effect: Roof Exceeds CEnC 110.8(i) & CEnC 140.3(a) 1A requirements by 10%	1			
Category Point Subtotal	11			
Water Efficiency				
M1a. Install Separate Meters: For each individual tenent space projected to consume > 100 gal-day 5:303.1.1	М	-		
M1b. Install Separate Meters: For each tenant within building projected to consume > 1000 gal/day 5.303.1.2	M			
M2. Meet City of Santa Cruz Water Efficient Landscaping Ordinance satisfying CALGreen 5.304.2(1)	M			
M3. Plumbing Fixtures & Fittings: Demonstrate compliance with 5:303.3	M			
M4. Plumbing Fixtures installed in accordance with California Plumbing Code: 5:303.6	M			
5. Outdoor Potable Water Use: Exceed Mandatory Minimums	1			
 Plumbing Fixtures & Fittings: Reduce Water Use 50% beneath Mandatory Limit 5:303.3 	1			
Develop Landscape Irrigation Budget: Reduce Water Use 50% beneath Mandatory Limit	1	-		
8. Water Efficient Landscaping: No Potable Water Use for Irrigation	1			
9. Innovative Wastewater Technologies: Exceed Mandatory Minimums	1			
 Water Use Reduction: Reduce Water Use 30% beneath mandatory limit using voluntary measures 	2			
Category Point Subtotal	7			
Energy and Atmosphere				
M18. Building Systems Commissioning: Required for New Structures 2 10,000 SF + OPR & BOD 5,410 2	M			
M15. Testing and Adjusting: For New Structures < 10,000 SF, demonstrate compliance with 5,410.4.2	M			
M2. Minimum Energy Performance (Title 24)	M			
M3. Food Waste Disposers: 5 IGPM in standby mode OR 10min shutoff 8 5 8 GPM in use (Commercial Kitchens): 5 303.4.1	M	-		
M4. Insulate Hot Water Pipes: CEnC 120.3	M			
M5. Solar Zone: Indicate 80 SF Solar Zone if Structure s 10,000 SF or 160 SF Solar Zone if Structure > 10,000 SF CEnC 110.10	14	-		
Optimize Energy Performance: 1 to 10 Points Based on Energy Simulation Calculations	10			

DANCE STUDIO 1020 RIVER STREET SANTA CRUZ, CA	TANNERY VARTS CENTER
1020 RIVER STREET SANTA CRUZ, CA	DANCE STUDIO
	1020 RIVER STREET SANTA CRUZ, CA

City of Santa Cruz - Non-Residential New Construction Green Building Checklist - Version Date: Mar 1st, 2017

Project Audiess
Variety (TAM)

Assessor Pared (TAM)

Project Recognition

Observed

Control

TAC DANCE STUDIO | 1020 RIVER STREET

7b. On-Site Renewable Energy: Supply 3%	1			
7c, On-Site Renewable Energy: Supply 5%	1			
7d. On-Site Renewable Energy: Supply 7%	1			
7e. On-Site Renewable Energy: Supply 9%	1			
7f. On-Site Renewable Energy: Supply 11%	1			
To, On-Site Renewable Energy: Supply 13%	1			
A Enhanced Commissioning	- 1			
9. Enhanced Refrigerant Management	1			
11. Heavurement and Verification	1			
10. Green Power: Contract at least 35% of Electric Energy for 2 year minimum duration	1			
* 11. Locate Prominent Stainway in Lobby	2	-		
* 12. Pre-wire for Photovoltaic Installation: Exceed 80 SF or 150 SF Roof Solar Zone + add Electrical Receiver Path	1			
 13. Pre-alumb for Thermal Solar Installation: Indicate Roof Solar Thermal Zone & HTF Path to Mechanical Room 	1			
* 14. Design and Construct Grid Neutral/Net Zero Building	10			
Category Point Subtotal	35			
D. Materials and Resources		_		
 M1, Weather Protection: Specify Weather Resistant Exterior Well & Foundation per CBC1403.2 	М			
M2s. Moisture Control: Demonstrate sprinkler spray zone(s) exclude any structure(s) 5.407.2.1	M	-		
M2b. Moleture Control: Enthes/Coerinos protected w/ 2 ff marcin 5, 4 ff Avrino/Overhano/Recess OR equiv 5,407,2,2,1	M	-		
M2c. Moisture Control: Flashing integrated with a drainage plan 5.407.2.2.2.	M	-	_	
M.C. Mosture Collection of Recyclables: Demonstrate compliance with 5.410	M			
M4. Construction Waste Management Plan: Complete City of Santa Cruz's CWMP to comply with 5.408.1.1	M	-		
MS. Construction Waste Management: Divert 65% to corrolly with 5.405.1	M	-		
MG. Excavated Soil and Land Clearing Debris: 100% reused or recycled 5.408.3	M	-		
Mb. Excavated Soil and Land Cleaning Debris: 100% reused or recycled 5.408.3 M7. Functional Performance Testing: Test Reporting Results for each Building System & Interface 5.410.2.4 if ≥ 10K SF	M			
MS. Building Systems Manual and Building Systems Training: Satisfy 5.410.2.5 if a 10K SF or only 5.410.4.5 if < 10K SF	M			
 Construction Waste Management: Divid 75% of Above 		-		
Construction Waste Management: Divirt 75% or Above Building Reuse: Maintain 75% Existing Walls, Floors, Roof	1			
10a. Building Reuse: Maintain 75% Easting Walls, Floors, Roof	1	_		
10b. Building Reuse: Mointain 100% Existing Walls, Floors, Roof 10c. Building Reuse: Mointain 100% Existing Walls, Floors, Roof, and 50% of Non-Structural Elements.	1	_		
	1	_		
11a. Materials Reuse: Specify 5%, follow online guidelines for eligibility & documentation	1	_		
11b. Materials Reuse: Specify 10%, follow online guidelines for eligibility & documentation	1	_		
12s. Recycled Content: Specify 10%, follow online guidelines for eligibility & documentation	1			
12b. Recycled Content: Specify 20%, follow online guidelines for eligibility & documentation	1	_		
13a. Regional Materials: 10%, follow online guidelines for eligibility & documentation	- 1			
13b. Regional Materials: 20%, follow online guidelines for eligibility & documentation	1			
14. Rapidly Renewable Materials: Use a minimum of 2.5% rapidly renewable materials by cost	1			
15. Certified Wood: Specify minimum 30% FSC timber in plans	1			
★ 16. Advanced Wood Framing Techniques: Reduce timber use, either 19.2 ° OC or 24° OC framing	1			
Category Point Subtotal	13			
M1. Indoor Moleture Control: Demonstrate Compliance with CBC 1203 & CBC Ch 14 per CAL Green 5.505.1	M	-		
M2. Cover Duct Openings During Construction & MERV 8 Filters: Demonstrate Compliance w/ 5:504.1 & 5:504.3	M			
M3. Resilient Flooring Systems (80% of total floors): Demonstrate compliance with 5.504.4.6	М			
M4. Filters for Nechanically Vertilated Buildings: Minimum MERV 8, Demonstrate Compliance with 5:504.5.3	M	-		
M5. Carbon Dioxide (CO2) Monitoring: Demonstrate compliance with CEnC 120(c)(4) per CAL Green 5.506.2	М			
M6. Outdoor Air Delivery Monitoring: Demonstrate compliance with CEnC 120.1	М			
M7s. Low VOC-Emitting Materials: Achesives & Seatants 5.504.4.1	M			
M7b. Low VOC-Emitting Materials: Paints & Coatings 5.504.4.3	м			
M7c. Low VOC-Emitting Materials: Carpet and Composite Wood Flooring Systems 5.504.4.4 & 5.504.4.5	М			
City of Santa Cruz - Non-Besidential New Construction Green Buildian Charlette - Ver-	ion Da	er Mar	141 2017	Pare

TAC DANCE STUDIO | 1020 RIVER STREET

M76. Low VOC-Emitting Materials: Composite Wood & Agrifiber Products 5.504.4.5	M			
M5. Environmental Tobacco Smoke Control: Provide 25' separation to entries, air intakes & operable windows 5.504.7	M			
M9. Ozone Depletion: HVAC, Refrigeration & Fire Suppression are CFC & Halon free 5.508.1	M	-		_
M10. Supermarket Refrigerant Leak Reduction: Where Applicable for Structures > 8,000 SF if refrigerant GWP > 150 5,508 ;				
M11. Acoustical Control: Demonstrate Compliance with 5:507.4	M	-		
12. Minimum IAQ Performance: Meet the minimum requirements of Section 4-7 of the ASHRAE 62.1	- 1			
13. Increased Ventilation: Exceed Minimum Requirements	1			
14. Resilient Flooring Systems: Exceed Mandatory Minimums	1			
15e. Construction IAQ Management Plan: During Construction	1			
15b. Corretruction IAQ Management Plan: Before Occupancy	1			
16. Indeor Chemical & Pollutant Source Control	- 1			
178. Controllability of Systems Design: Provide Task or Natural Lighting for a 90% of occupants A 507.1.1.1	1			
17b. Controllability of Systems Design: Provide Thermal Control for a 50% of occupants A 507.1.1.2	1			
 Lighting Control Verification: Field Verify Task or Natural Lighting for it 90% of occupants A 507.1.1.1 	1			 _
 Thermal Comfort Verification: Field Verify Thermal Control for ≥ 50% of occupants A 507.1.1.2 	- 1			_
 Daylight & Views: If ≤ 5,000 SF satisfy CEnC 140.3(c) or If > 5,000 SF then exceed by 10% CEnC 140.3(c) 	1			
21. Acoustical Control: Exceed Mandatory Minimums of CALGreen 5:507.4 by 10% in STC	- 1			_
Category Point Subtotal	12			_
Innovation in Design				
1. Green Building Accredited Professional	1			

GENERAL NOTES:
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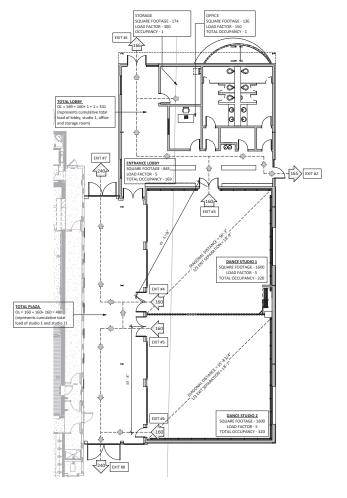
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GREEN BUILDING CHECKLIST

JOB NO.	SHEET NO.
DATE:	
DRAWN:	G0.15
CHECKED:	
ISSUE: PLANNING SUBMITTAL	OF SHEETS

City of Santa Cruz - Non-Residential New Construction Green Building Checklist - Version Date: Mar 1st, 2017





GROUND LEVEL EXITING PLAN

1/8" = 1'-0"

EXIT WIDTH CALCULATIONS:

EXI'	Γ#		EXIT WIDTH REQUIRED	EXIT WIDTH PROVIDED
#1	-	166 x 0.2 =	33.2"	68"
#2	-	165 x 0.2 =	33"	40.5"
#3	-	160 x 0.2 =	32"	68"
#4	-	160 x 0.2 =	32*	68"
#5	-	160 x 0.2 =	32"	68"
#6	-	160 x 0.2 =	32"	34"
#7	-	240 x 0.2 =	48"	96"
#8	-	240 x 0.2 =	48"	120"


GENERAL NOTES.
CONTRACTOR SHALL FIELD VERIFY ALL JOB CONDITIONS AND DIMENSIONS VARIATIONS TO THEREFOR FROM THE DRAWINGS MUST BE REPORTED TO THE ARCHITECT. DETAILS INDICATED ON THE DRAWINGS ARE REPRESENTATIVE AND THE CALL ALL ATTACHMENTS AND CONNECTIONS ALL CONFORM TO BEST PRACTICE AND SHALL BE THE CONTRACTOR'S RESPONSIBILITY.


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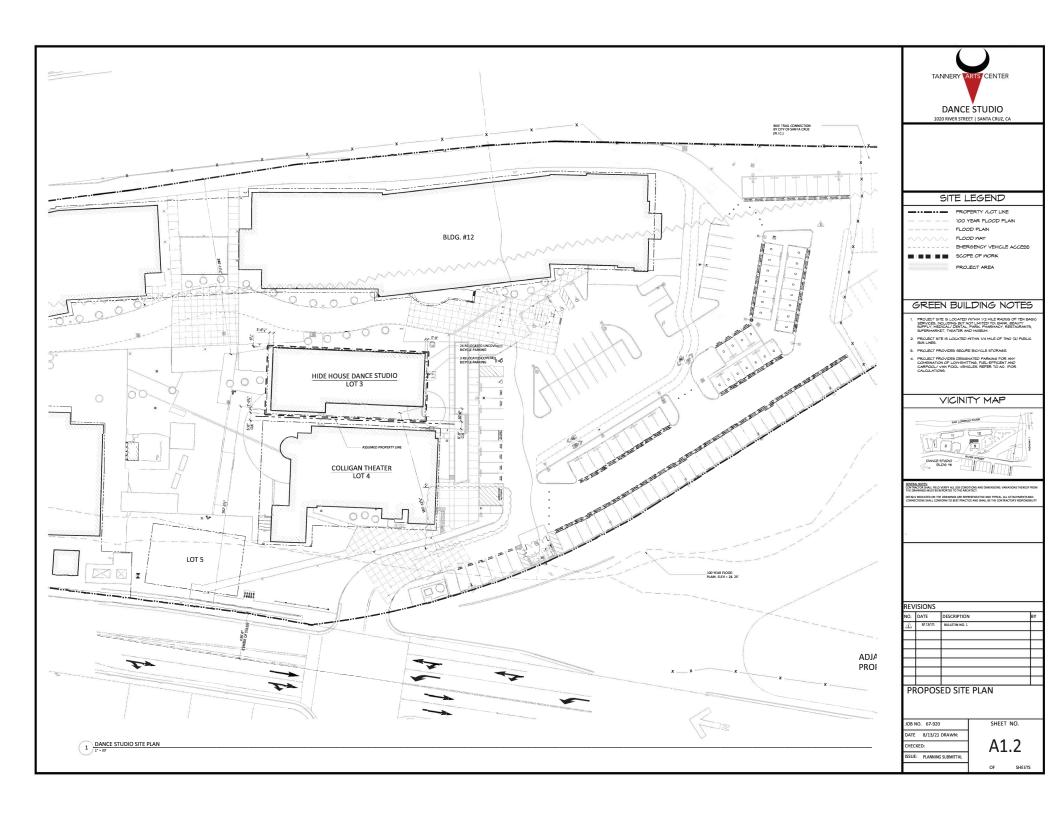
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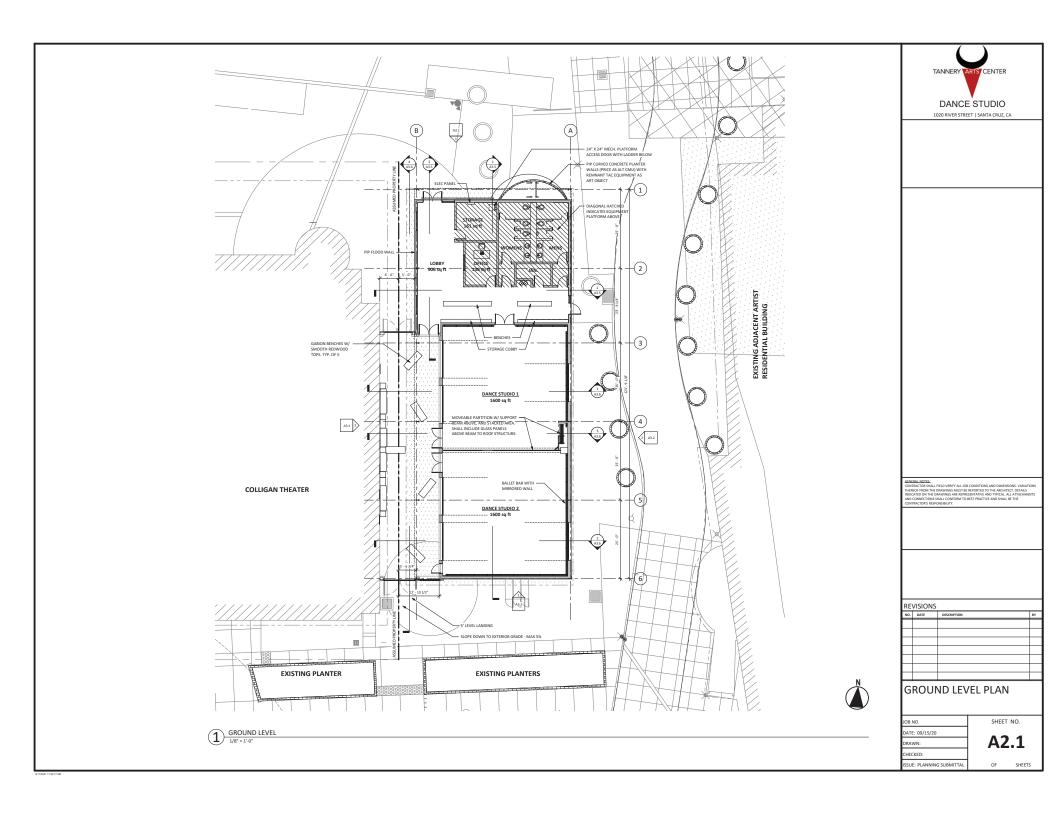
EXITING PLANS


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DATE: 09/15/20	
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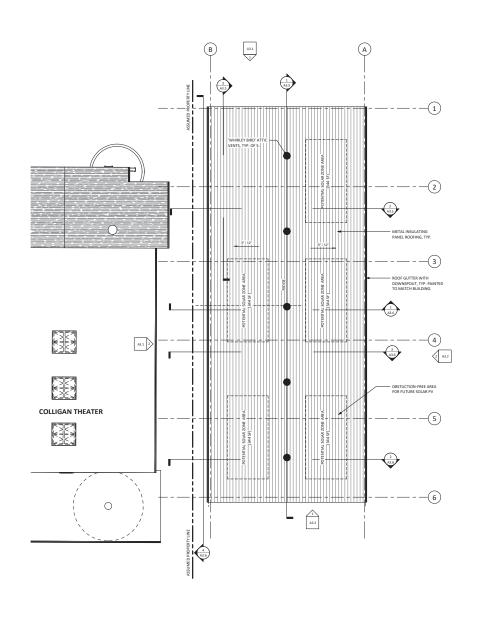






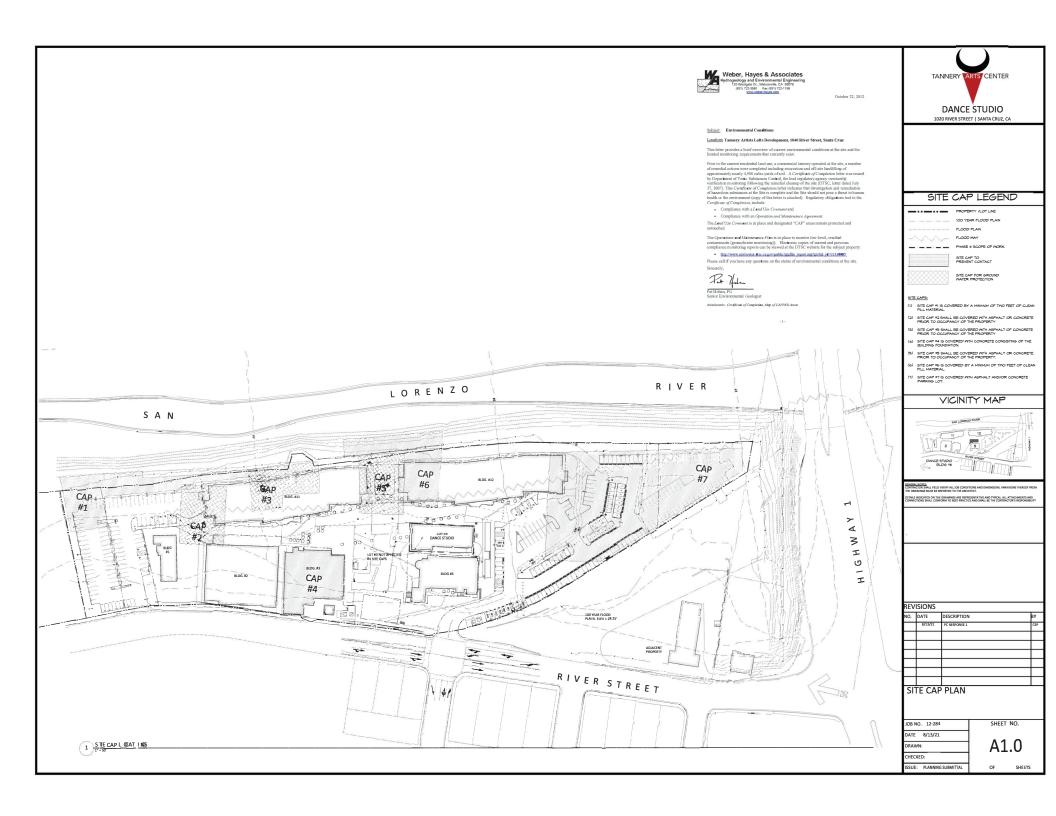

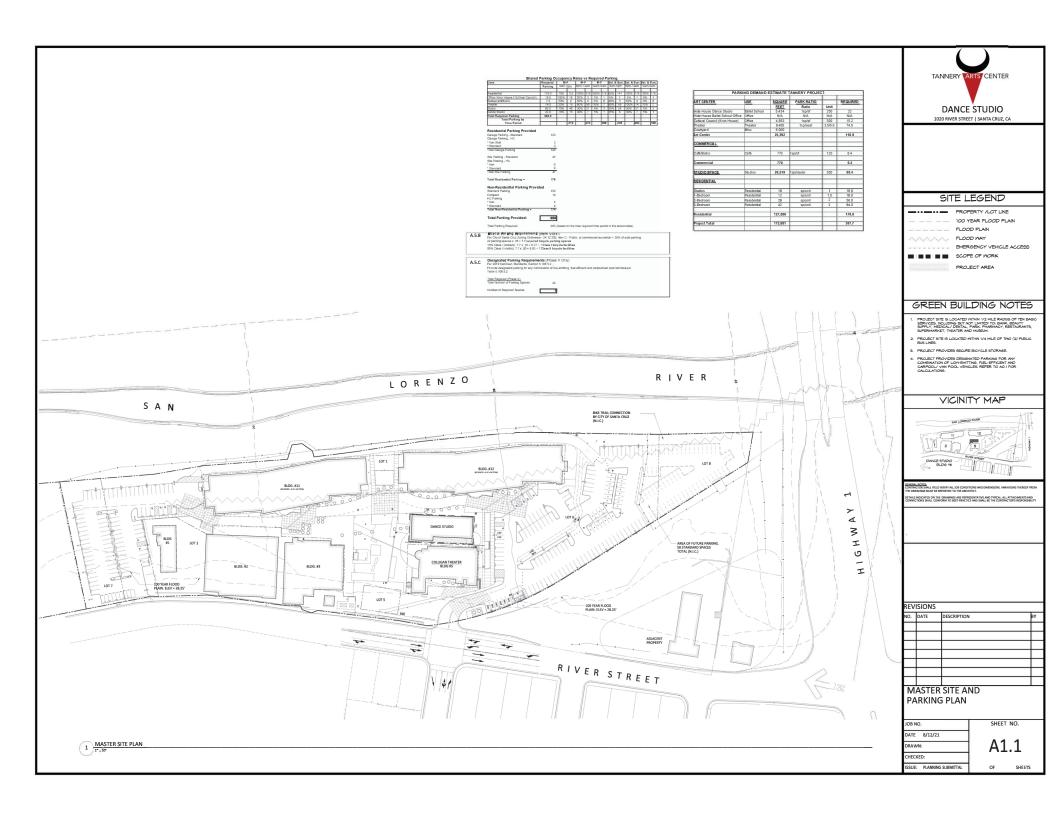

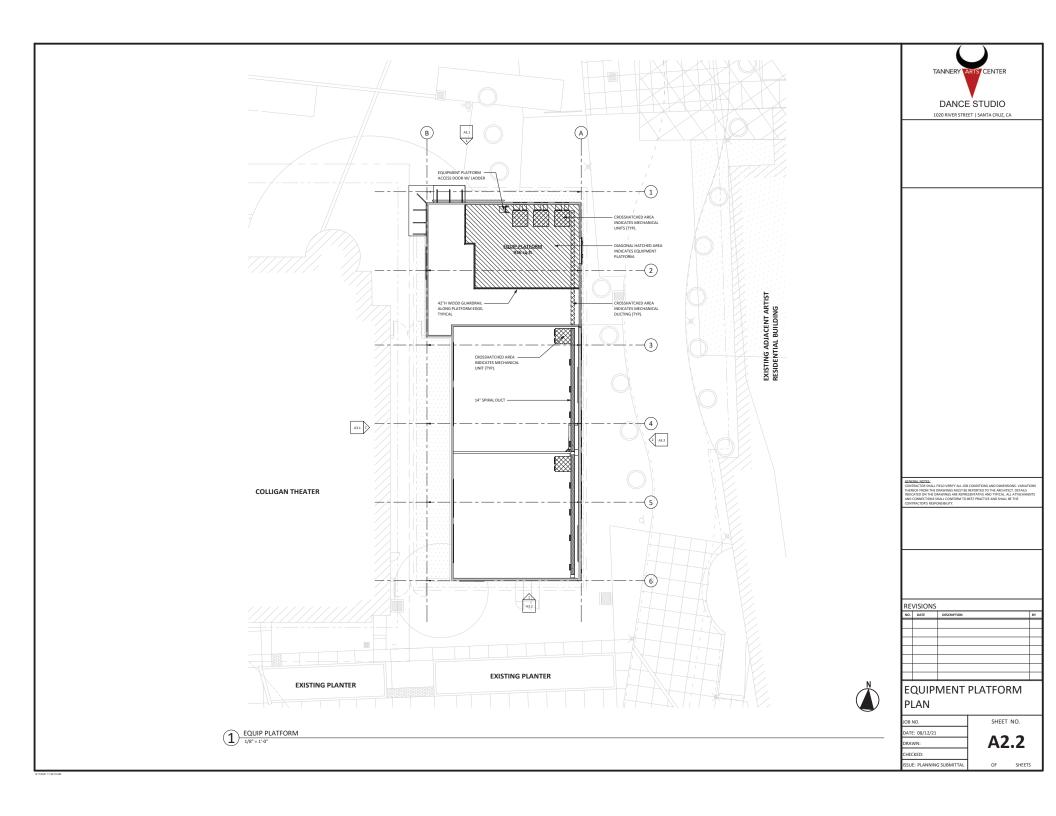



1020 RIVER STREET | SANTA CRUZ, CA

SOLAR READY AREAS:

THE CITY ENCOURAGES THIS BUILDING DESIGN TO EXCEED THE REQUIRED 15%, OBSTRUCTION-FREE, MINIMUM ROOF AREA FOR SOLAR PY (CEnC 110.10(b).18) AND ACHEIVE A 25% SOLAR PY READY ROOF AREA THROUGH EFFICIENT LAYOUT OF ROOFTOF ME

REQUIRED MIN SOLAR ZONE = ROOF AREA x 25% = 6,500 x 25% = 1,626 SF REQUIRED

SOLAR ZONE PROVIDED = 1,720 SF

GENERAL NOTES.
CONTRACTOR SHALL FIELD VERIFY ALL JOB CONDITIONS AND DIMENSIONS VARIATIONS TO THEREFOR FROM THE DRAWINGS MUST BE REPORTED TO THE ARCHITECT. DETAILS INDICATED ON THE DRAWINGS ARE REPRESENTATIVE AND THE CALL ALL ATTACHMENTS AND CONNECTIONS ALL CONFORM TO BEST PRACTICE AND SHALL BE THE CONTRACTOR'S RESPONSIBILITY.

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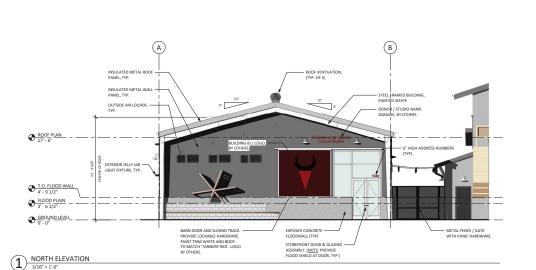
ROOF LEVEL PLAN

JOB NO.
DATE: 08/12/21
DRAWN:
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SHEET NO. A2.3

ROOF PLAN

1/8" = 1'-0"



EXTERIOR 'JELLY-JAR' LIGHT FIXTURE, TYP.

WEST ELEVATION
3/16" = 1'-0"

EXPOSED CONCRETE -FLOODWALL, TYP. METAL INSULATING PANELS AT ROOF AND WALLS



GENERAL MOTTES

CONTRACTOR SHALL REEL WEBT PALL IOR CONDITIONS AND DARRISONS. WARRATON

CONTRACTOR SHALL REEL WEBT PALL IOR CONDITIONS AND DARRISONS. WARRATON

RECRETATE OF DAMMINGS AND REPRESENTATIVE AND THYCLE, ALL ATTACHMENTS

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TANNERY ARTS CENTER

DANCE STUDIO

1020 RIVER STREET | SANTA CRUZ, CA

BUILDING ELEVATIONS

JOB NO.

DATE: 09/15/20

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ISSUE: PLANNING SUBMITTAL

A3.1

SHEET NO.


11/2021 11:

ROOF PLAN


T.O. FLOOD WALL 4' - 9 1/2"

GROUND LEVEL



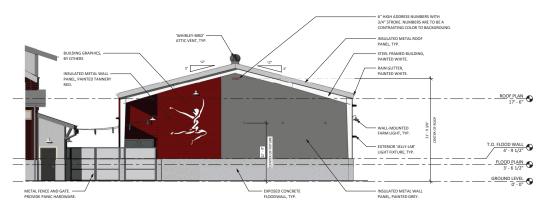

 $(1) \frac{\text{SOUTH ELEVATION}}{_{3/16"}=1'\cdot0"}$

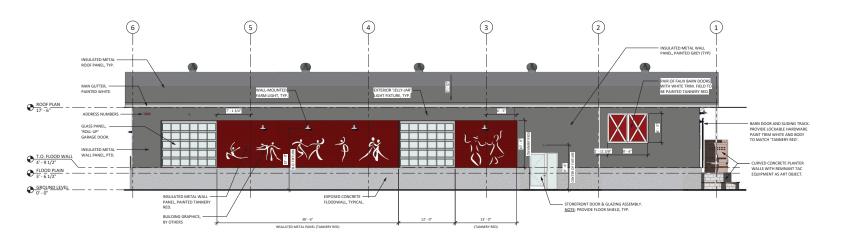

2 EAST ELEVATION
3/16" = 1'-0"

GENERAL HEITES.


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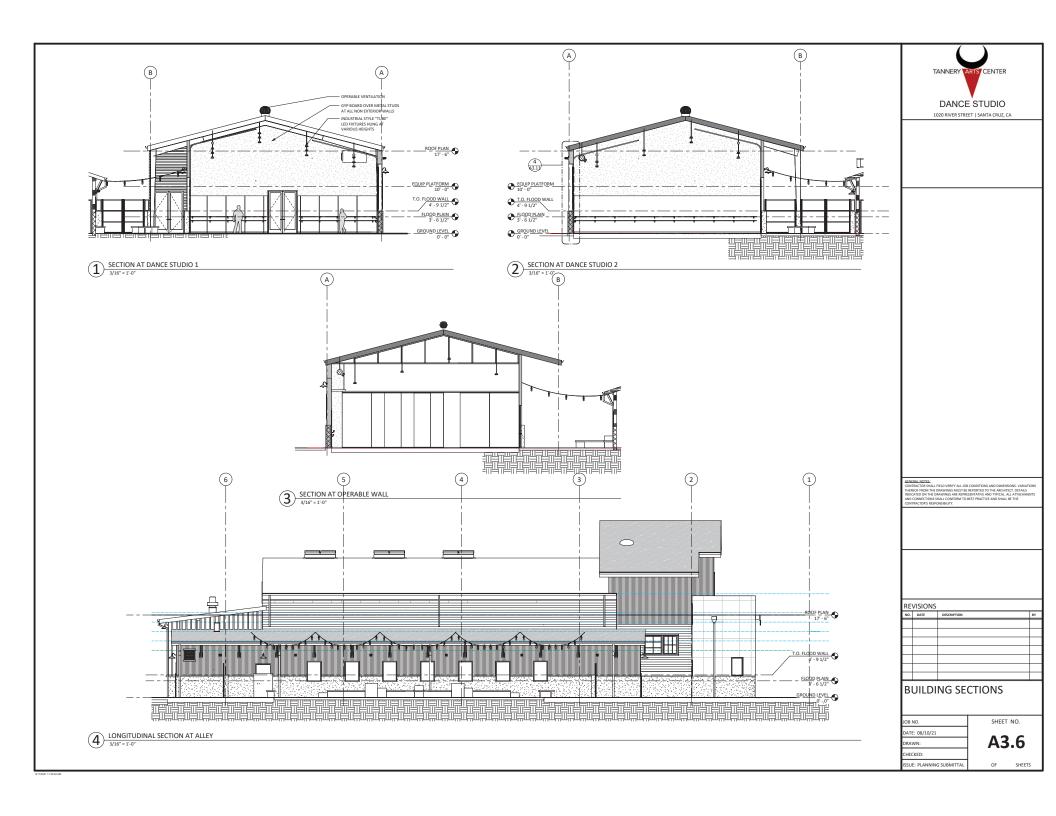
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BUILDING ELEVATIONS

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Catalog #	Description	Ballast	Socket	Lamp	Weight	Starting Temperature	Lamp Output	Lamp Color Rendition
E-MT7M07DG			Porcelsin, 4-kv medium base	Clear, medium base (-MH070ME)	10.8 Pounds	-22°F, -30°C	5040 lumens	65 CRI

Fe	satures	
- Neon-Cub, dis-cast furnisms housing and adopter, with grey pulposts prosent cool firsh - Easy-matil, scree-in, clear glass jet - 5 threaded and plugged 34° conduit entry points - 5 threaded and plugged 34° conduit entry points	Discost disminum 4-inch junction box UL Listed for well location Typian seatractly	
Ann	essories	

1501 96" Street Sturtevant, Wisconsin 53177 I (888)243-9445 I Fax (262)504-5409 I www.e-conolight.com


EXTERIOR 'JELLY-JAR' LIGHT FIXTURE:
SURFACE MOUNTED UTILITY LIGHT WITH METAL CAGE

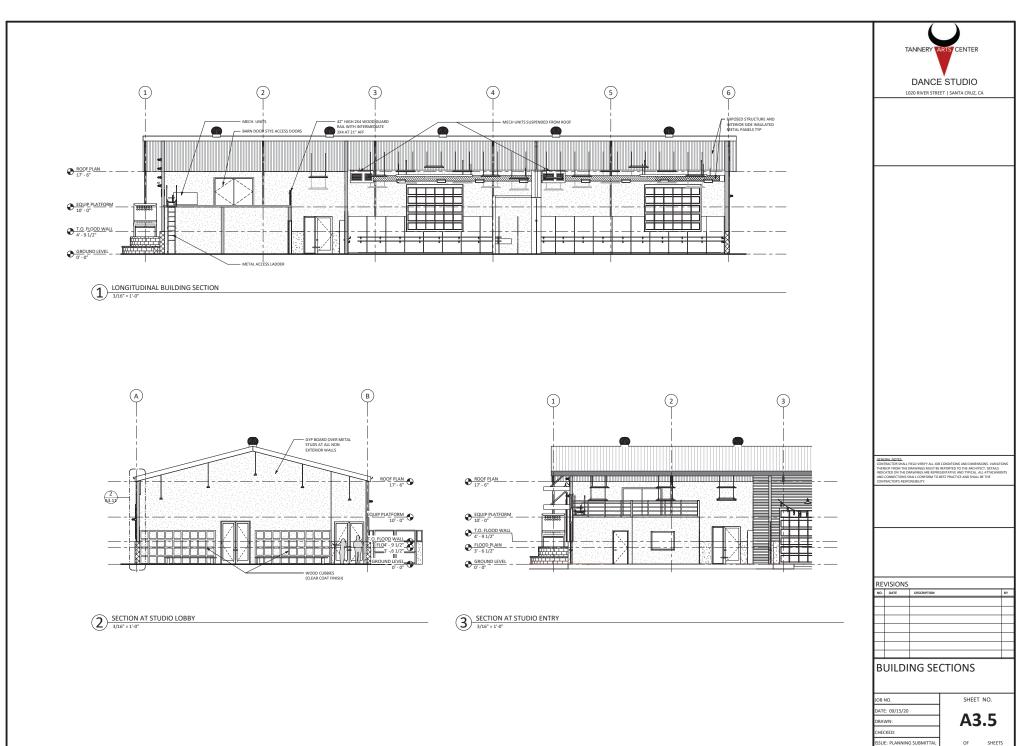

http://www.restorationhardware.com/catalog/product/product.jsp?productId=prod1677169... 11/6/201

EXTERIOR LED STRING LIGHTS:
DECORATIVE STRING LIGHTS TO ENHANCE OUTDOOR
GATHERING SPACE.



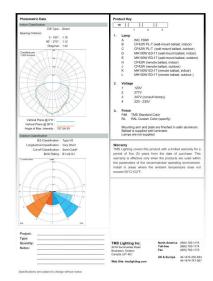

EXTERIOR DOORWAYS / ENTRACES:

WALL-MOUNTED FARM LIGHT w/ 12" DIAMETER REFLECTOR. INSIDE OF REFLECTOR PAINT WHITE AND THE EXTERIOR TO BE BLACK.




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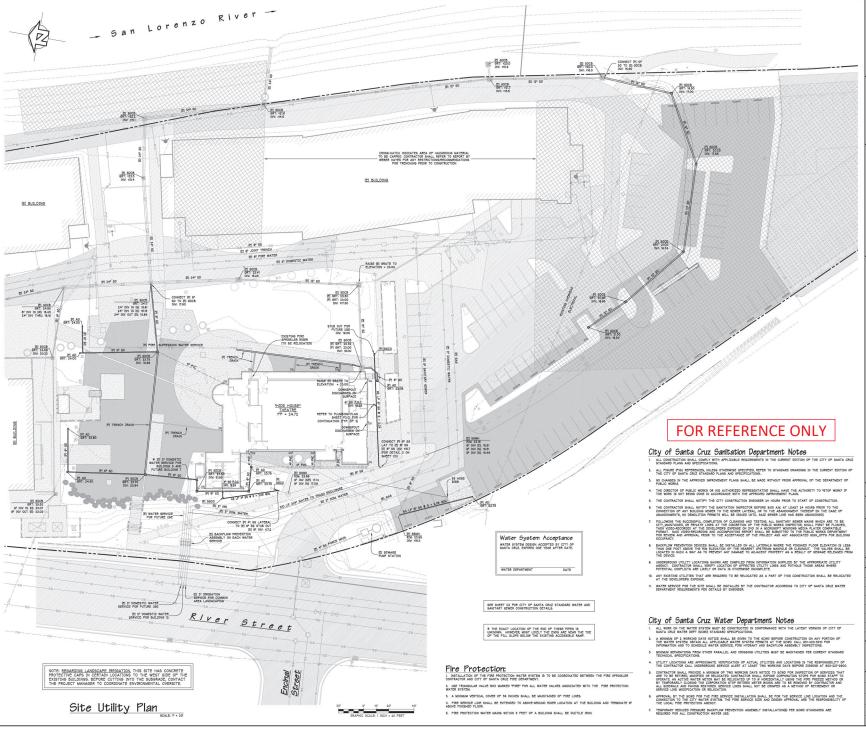
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1020 RIVER STREET | SANTA CRUZ, CA

JOB NO.	SHEET NO.
DATE: 08/12/21	
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River Street Santa Cruz, California



www.iflandengineers.com

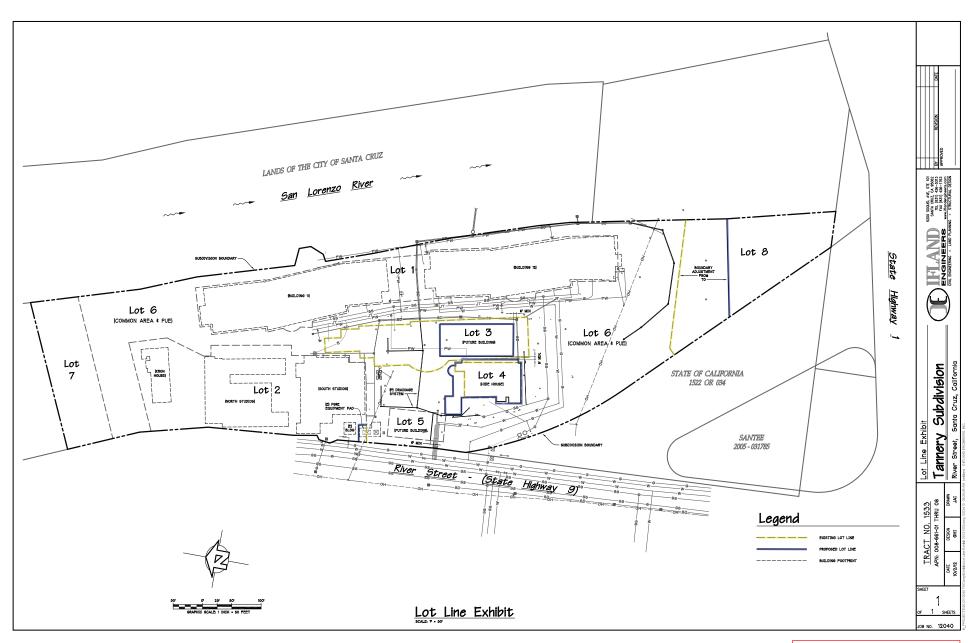

PHASE IV HIDE HOUSE THEATER

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SITE UTILITY PLAN

JOB NO.	IEI 12040
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ISSUE: PLAN	INING SUBMITTAL

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